

1 EXISTING SITE PLAN

0EC1.0 NO SCALE

06/06/2024 1/4'' = 1'-0'' DRAWING NO: PROJECT PHASE:

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Main

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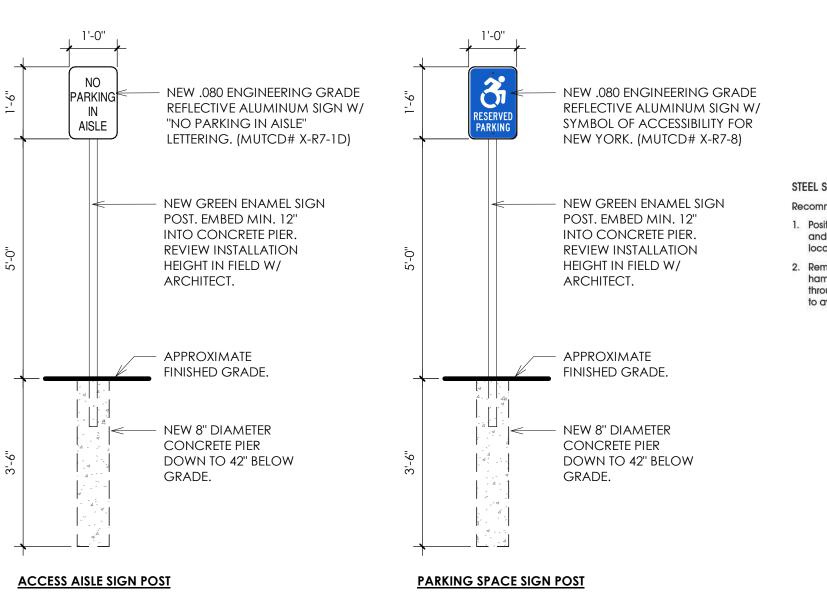
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Site Renov 1010,1( Fishkill, N

1 OF 4





## STEEL SPIKE METHOD (ASPHALT H-2310) Reposition the parking block in its installation position. Drive the spike through the parking block and into the Recommended for asphalt or wood block surfaces only. drilled hole until the spike is snug against the counterbored surface of the parking block's pre-drilled hole. Position the parking block in its installation position and, using its pre-drilled holes as templates, mark the location for each hole on the parking surface. Remove the parking block. Using a high-speed hammer drill and a 3/8" masonry bit, drill a hole through the parking surface of each marked location to avoid fracturing the asphalt with the spike. 6', PLASTIC, YELLOW.

<sup>2</sup> PARKING STOP DETAIL

1.5" x 5.5"x 94" heavy duty pocket rails

• 7/8" x 6" x 62.25" tongue & groove pickets for White and Tan • 7/8" x 11.3" x 62.25" tongue & groove pickets for Woodgrain

6 ft tall x 8 ft wide solid privacy

Aluminum Insert in Bottom Rail


5" x 5" x 96" or 108" posts

Available in white or tan

1" x 59" U-Channel

Style #265

\2SP1.1/ NO SCALE

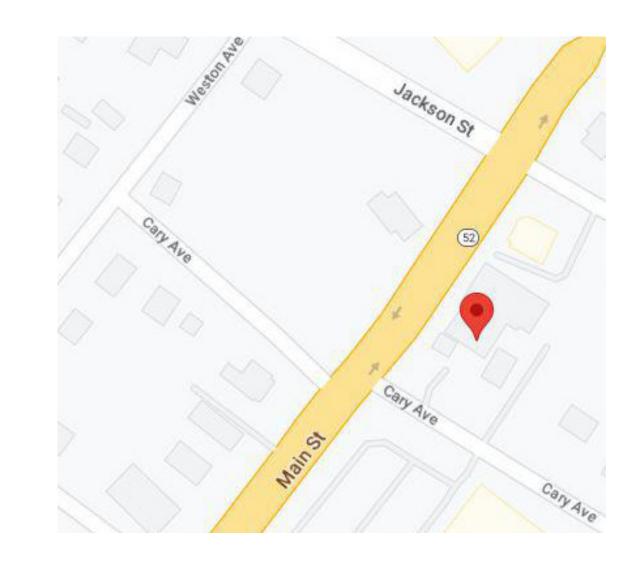

LOCATION MAP

NONE

**OFF-STREET PARKING REQUIREMENTS-**

PROFESSIONAL SERVICES: 1 SPACE / 300 GSF

6 PARKING SPACES + 1 H.C. SPACE = 7 TOTAL SPACES

1,900 GSF / 300 = 7 SPACES

\*GSF OF 1,900 REFERS TO THE ENTIRE SQUARE FOOTAGE OF THE EXISTING RESIDENTIAL

\*GSF OF 7,650 REFERS TO THE ENTIRE SQUARE FOOTAGE OF THE EXISTNG PROFESSIONAL

PROFESSIONAL & BUSINESS OFFICES

0.28 ACRES

NO CHANGE

NONE NONE

57 FT 218 FT

2SP1.1/ NO SCALE

**ZONING INFORMATION - PARCEL 1** 

ORDINANCE REQUIREMENT:

**ZONING INFORMATION - PARCEL 3** 

ORDINANCE REQUIREMENT:

\*SEE PARKING SPACES 1 - 7

REQUIRED:

PROVIDED:

BUILDING.

EXISTING:

PROPOSED:

TOWNSHIP: VILLAGE OF FISHKILL, NY

SECTION, BLOCK, LOT: 6155-07-712878

ZONE: VC-BD, HISTORIC PRESERVATION OVERLAY



4 PARTIAL ZONING MAP 2SP1.1 NO SCALE

MAX. BLDG.

HEIGHT

+/- 15 FT

35 FT

MIN. REAR YD.

ACCESSORY BLDG. | ACCESSORY BLDG.

N/A

MAX BLDG.

COVERAGE

NO CHANGE NO CHANGE 66%

50 %

34 %

MAX. BLDG.

FOOTPRINT

5,000 SF

4,268 SF

MAX. LOT

80 %

COVERAGE

MIN. SEPARATION

BETWEEN BLDGS.

10 FT

+/-3.4 FT

NO CHANGE


MIN. SEPARATION


BETWEEN BLDGS.


+/-3.4 FT


NO CHANGE

## 1 ADA SIGNAGE DETAILS 2SP1.1 1/2" = 1'-0"

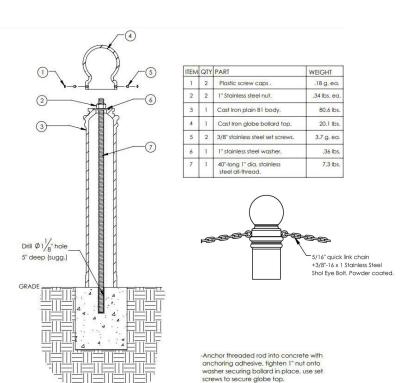

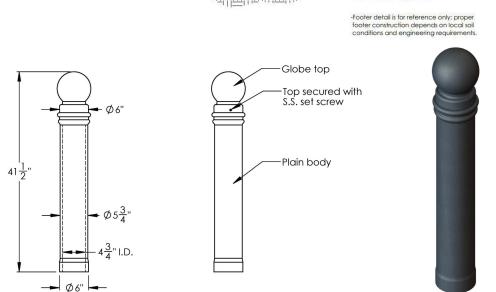

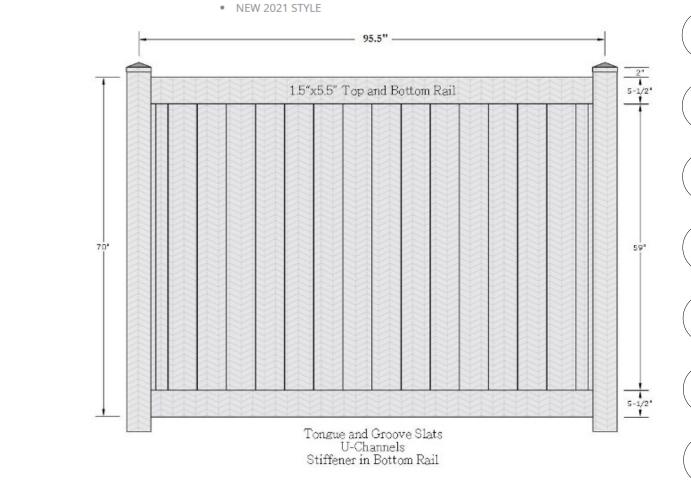

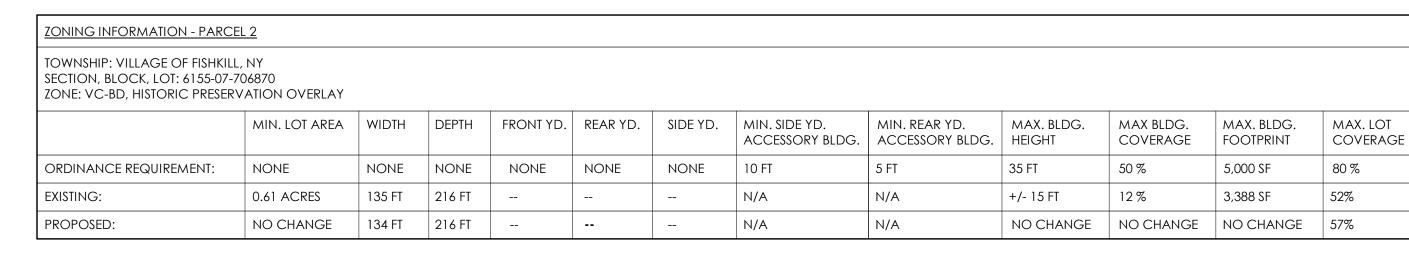

NONE

FRONT YD. REAR YD. SIDE YD.

NONE

NONE

## BOLLARD DETAILS





| TOWNSHIP: VILLAGE OF FISHKILL,<br>SECTION, BLOCK, LOT: 6155-07-70<br>ZONE: VC-BD, HISTORIC PRESERV | 06870-0002    |        |       |           |          |          |                                  |                                  |                      |                       |                         |                      |                                   |
|--|---------------|--------|-------|-----------|----------|----------|----------------------------------|----------------------------------|----------------------|-----------------------|-------------------------|----------------------|-----------------------------------|
|  | MIN. LOT AREA | WIDTH  | DEPTH | FRONT YD. | REAR YD. | SIDE YD. | MIN. SIDE YD.<br>ACCESSORY BLDG. | MIN. REAR YD.<br>ACCESSORY BLDG. | MAX. BLDG.<br>HEIGHT | MAX BLDG.<br>COVERAGE | MAX. BLDG.<br>FOOTPRINT | MAX. LOT<br>COVERAGE | MIN. SEPARATION<br>BETWEEN BLDGS. |
| ORDINANCE REQUIREMENT:   | NONE          | NONE   | NONE  | NONE      | NONE     | NONE     | 10 FT                            | 5 FT                             | 35 FT                | 50 %                  | 5,000 SF                | 80 %                 | 10 FT                             |
| existing:  | 0.11 ACRES    | 114 FT | 40 FT |           |          |          | N/A                              | N/A                              | +/- 30 FT            | 29 %                  | 1,337 SF                | 40%                  | +/-3.4 FT                         |
| PROPOSED:  | NO CHANGE     | 114 FT | 40 FT |           |          |          | N/A                              | N/A                              | NO CHANGE            | NO CHANGE             | NO CHANGE               | 66%                  | NO CHANGE                         |
|  |               |        |       |           |          |          |                                  |                                  |                      |                       |                         |                      |                                   |

PROPOSED CHANGE OF USE:

- EXISTING DOORWAYS WILL BE MODIFIED TO 3'-0".

- AN ACCESSIBLE ROUTE, AND RAMP WILL BE PROVIDED.

PROPOSED CHANGE OF USE FROM RESIDENTIAL TO COMMERCIAL

- EXISTING TOILET ROOMS WILL BE MODIFIED TO MEET CODE STANDARD. - ALL OFFERED SERVICES WILL BE ACCOMMODADTED ON THE FIRST FLOOR.

MIN. SIDE YD.

10 FT

N/A

N/A

## 1/2" or 3/4" CRUSHED STONE 5 1/2" CONCRETE 1" WASHED SAND GEOTEXTILE SUB-BASE -GEOTEXTILE · NATIVE SOIL -Single dumpster enclosure holds up to one 10 yard box or slant

COMPOSITE DUMPSTER ENCLOSURE.

COLOR: GREY.

| BUILDING.                        |  |     |                   |  |           |      |                            |  |  |  |
|----------------------------------|--|-----|-------------------|--|-----------|------|----------------------------|--|--|--|
| OFF-STREET PARKING REQUIREMENTS- |  |     | PLANTING SCHEDULE |  |           |      |                            |  |  |  |
| PROFESSIONAL & BUSINESS OFFICES  |  |     | KEY               | PLANT NAME   | SIZE      | ROOT | NOTES                      |  |  |  |
| ORDINANCE REQUIREMENT:           | PROFESSIONAL SERVICES: 1 SPACE / 300 GSF           |     | AB                | AUTUMN BRILLIANCE SERVICEBERRY  AMELANCHIER CANADENSIS | 8'-9' HT  | B&B  | MULTI-STEM PLANTS          |  |  |  |
| REQUIRED:                        | 7,650 GSF / 300 = 26 SPACES                        |     |                   | AMELANCHIER CANADENSIS                                 |           |      |                            |  |  |  |
| PROVIDED:                        | 25 PARKING SPACES + 1 H.C. SPACE = 26 TOTAL SPACES |     | PD                | PINK DOGWOOD<br>CORNUS FLORIDA                         | 3" CAL.   | B&B  | CALIPER MEASURED AT 4' HT. |  |  |  |
| *SEE PARKING SPACES 8 - 33       |  | ) [ |                   | EASTERN REDBUD   | 011 0 4 1 |      |                            |  |  |  |

- SINGLE TENANT LEASED SPACE.

7 REFUSE ENCLOSURE

\2SP1.1/ 1/4" = 1'-0"

2SP1.1/ NO SCALE

8 GRASSCRETE DETAIL

STONE FILLED SYSTEM


CALIPER MEASURED AT 4' HT. **CERCIS CANADENSIS** 

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3 OF 4 SW/LB 06/06/2024 As indicated

DRAWING NO:

PROJECT PHASE:

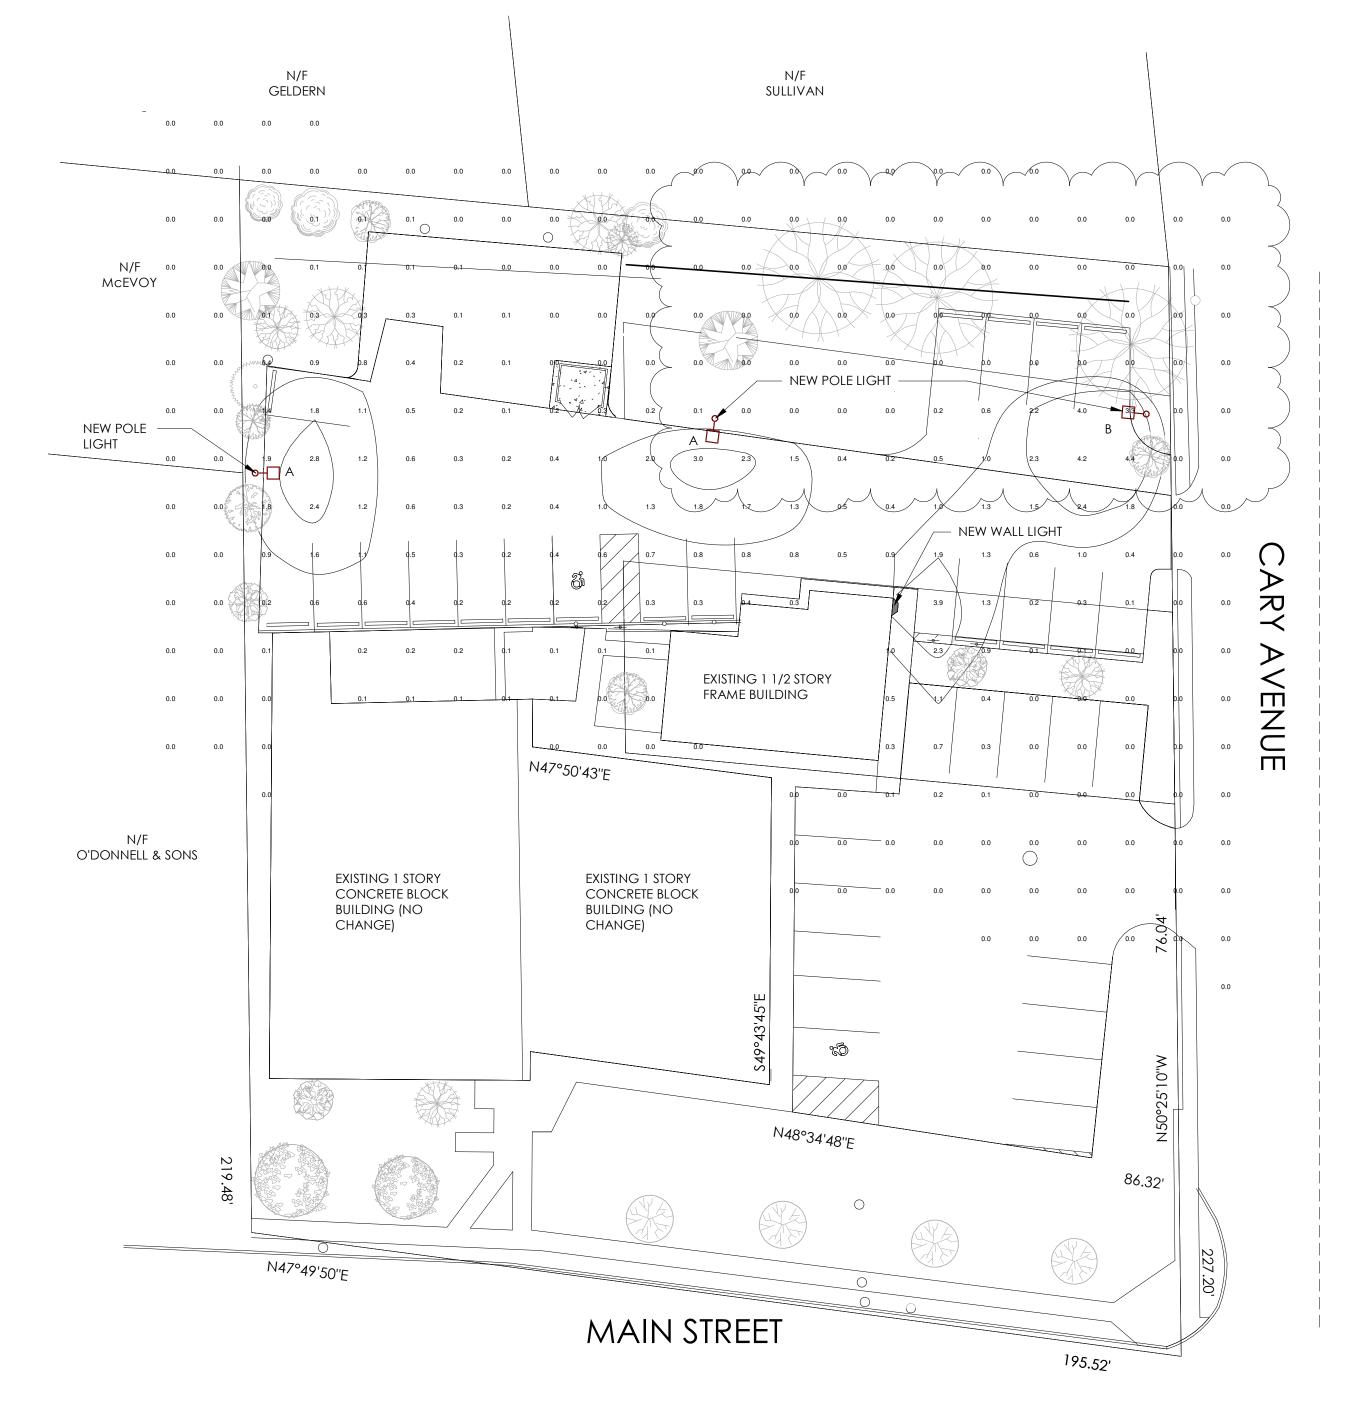

PHOTOMETRIC PLAN


LIGHTS WILL BE SET TO BE MOTION SENSOR ACTIVATED BETWEEN THE HOURS OF 10 PM AND 6 AM.

ALL LIGHTING FIXTURES ARE TO BE COMPLIANT WITH STANDARDS SET BY THE INTERNATIONAL DARK-SKY ASSOCIATION.

| LUMINAIRE SCHEDULE |          |  |                         |          |        |  |  |  |  |
|--------------------|----------|--|-------------------------|----------|--------|--|--|--|--|
| SYMBOL             | QUANTITY | LAMP   | COLOR                   | MOUNTING | HEIGHT |  |  |  |  |
|                    | 1        | LITHONIA MRW LED P1-30K-SR2-PIR-DDTXD  | TEXTURED<br>DARK BRONZE | WALL     | 12'    |  |  |  |  |
| A                  | 2        | D-SERIES SIZE 0 AREA LUMINAIRE P1 PERFORMANCE<br>PACKAGE 2700K CCT 80 CRI TYPE 4 EXTREAM BACKLIGHT<br>CONT (DSX0 LED P1 27K 80 CRI BLC4) | BLACK                   | POLE     | 12'    |  |  |  |  |
| В                  | 1        | D-SERIES SIZE 0 AREA LUMINAIRE P1 PERFORMANCE<br>PACKAGE 2700K CCT 80 CRI RIGHT CORNER CUTOFF (DSX0<br>LED P1 27K 80CRI RCCO EGS)        | BLACK                   | POLE     | 12'    |  |  |  |  |

LIGHTING NOTES:

ALL NEW LIGHTS TO HAVE A COLOR TEMPERATURE OF NO GREATER THAN 3,000K.

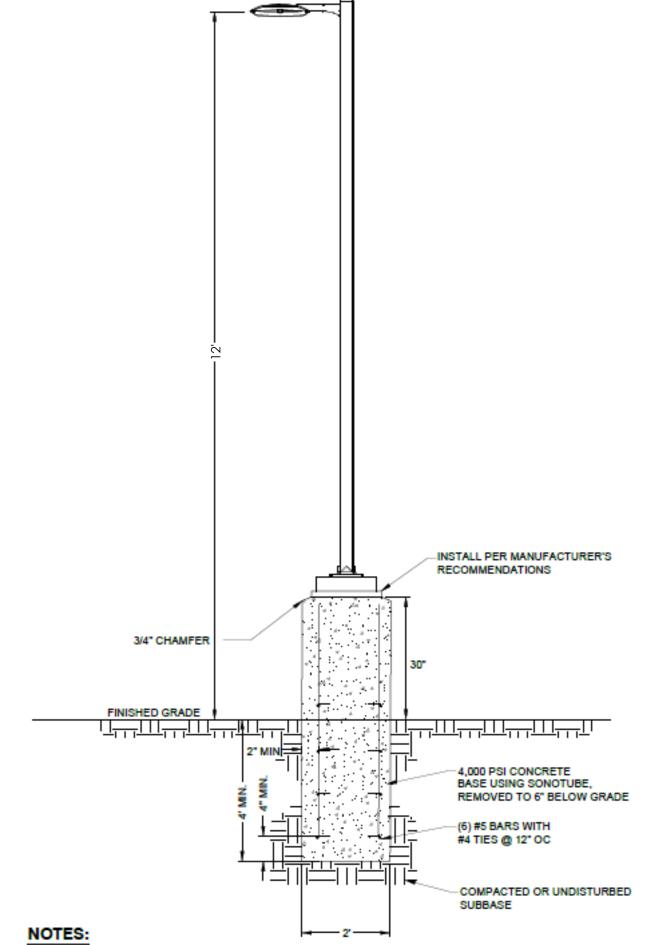

PROVIDE CONDUIT SLEEVE FOR ELECTRIC AND GROUNDING CONDUCTORS. ALL CONCRETE SHALL BE 3000 PSI AT 28 DAYS.

ALL CONCRETE EXPOSED TO GROUND/WEATHER SHALL BE AIR-ENTRAINED.
REINFORCING BARS SHALL BE HIGH BOND DEFORMED BARS MEETING ASTM A305 AND A615, GRADE

FOUNDATIONS SHALL BEAR ON UNDISTURBED NATURAL SOIL OR COMPACTED CRUSHED STONE. EXCAVATION AREA SHALL BE BACKFILLED WITH STRUCTURAL FILL AND COMPACTED TO 97%

171-34 EXTERIOR LIGHTING: D. IN ALL DISTRICTS, THE MAXIMUM POLE HEIGHT FOR ANY EXTERIOR LIGHT FIXTURES SHALL NOT EXCEED 12 FEET AS MEASURED FROM THE GROUND.



St. Main 1018

4 OF 4 SW/LB 06/06/2024 As indicated DRAWING NO:

PROJECT PHASE:

3 WALL PACK DETAIL - LITHONIA MRW LED 3SP1.2 NO SCALE

3SP1.2 NO SCALE

<sup>2</sup> LIGHT DETAIL - LITHONIA D - SERIES